



**PLANTING NOTES**

- ALL PLANT MATERIAL SHALL CONFORM TO THE GUIDELINES ESTABLISHED BY THE "AMERICAN STANDARD FOR NURSERY STOCK" PUBLISHED BY AMERICAN ASSOCIATION OF NURSERYMEN, LATEST EDITION, OR AS INDICATED IN THE PLANT LIST, WHICH SHALL GOVERN. REFER TO PLANTING SPECIFICATIONS FOR ADDITIONAL REQUIREMENTS.
- ALL PLANT MATERIAL SHALL BE FIELD SELECTED IN NURSERIES BY THE LANDSCAPE ARCHITECT AFTER PRELIMINARY TAGGING BY CONTRACTOR. ALL STOCK SHALL BE NURSERY GROWN.
- THE LANDSCAPE ARCHITECT SHALL REVIEW PLACEMENT OF PLANTS IN FIELD BEFORE INSTALLATION AFTER STAKING IN FIELD BY CONTRACTOR ACCORDING TO PLANTING PLANS AND SITE DETAILS. THE CONTRACTOR SHALL INFORM THE LANDSCAPE ARCHITECT IMMEDIATELY OF ANY CONFLICTS BETWEEN PROPOSED PLANT LOCATIONS AND BELOW GRADE UTILITIES, STRUCTURES, DRAINAGE PROBLEMS OR ANY OTHER PLANTING CONFLICT ENCOUNTERED OR ANTICIPATED AND REVIEWED WITH THE LANDSCAPE ARCHITECT BEFORE PLANTING COMMENCES.
- THE CONTRACTOR SHALL SUPPLY ALL PLANT MATERIALS IN SIZES AND QUANTITIES SUFFICIENT TO COMPLETE THE PLANTING SHOWN ON THE DRAWINGS. THE CONTRACTOR SHALL PLANT TREES AT THE SPACING INDICATED ON THE PLANS. THE LANDSCAPE ARCHITECT HAS THE RIGHT TO REJECT INJURED, DISEASED, DESIGNATED OR INCORRECT SPECIES AT ANY TIME.
- ALL PLANTS THAT ARE DELIVERED TO THE SITE AND NOT PLANTED IMMEDIATELY SHALL BE STORED AND WATERED PROPERLY, ACCORDING TO THE SPECIFICATIONS, IN SECURE LOCATIONS REVIEWED BY THE LANDSCAPE ARCHITECT. ALL PLANTS SHALL HAVE ONE YEAR GUARANTEE.
- ALL TREES SHALL BE STAKED OR ANCHORED SECURELY AND ACCORDING TO THE SITE DETAILS.
- ALL NEW AND EXISTING PLANT MATERIAL WITHIN THE LANDSCAPE LIMIT OF WORK LINE SHALL BE PRUNED AFTER PLANTING TO REMOVE ALL DEAD OR DAMAGED BRANCHES. TREE WOUND DRESSING SHALL NOT BE USED ON ANY PLANTINGS. ALL NEW PLANTINGS SHALL BE WATERED FROM DELIVERY UNTIL THE END OF THE GUARANTEE PERIOD.
- ALL PLANTS SHALL BEAR THE SAME RELATION TO FINISHED GRADE AS TO ORIGINAL GRADE BEFORE DIGGING, UNLESS OTHERWISE DETAILED, AND SHALL HAVE A MULCHED SAUKER ACCORDING TO DETAILS.
- ALL PAPER, PLASTIC CONTAINERS AND IRON FASTENERS SHALL BE REMOVED FROM PLANTS BEFORE SETTING IN PLANT PIT. TURN DOWN BURLAP AND ROPE ONE-HALF ROOTBALL DEPTH (MIN). WIRE BASKETS SHALL BE CUT OFF AT BOTTOM OF ROOTBALL AND DISCARDED.
- EXISTING TOPSOIL SHALL BE UTILIZED FOR LOAM OR PLANTING SOIL MIXTURES ONLY IF TESTING INDICATES TOTAL CONFORMITY TO SPECIFICATIONS FOR LOAM BORROW. ALL GRASS, SOD, ROOTS, SHELLS AND STONES OVER HALF-INCH DIAMETER SHALL BE REMOVED AND LEGALLY DISPOSED OF.
- MULCH WITH 2" DEPTH SHREDDED PINE BARK TO LIMITS OF BED IN LOCATION SHOWN ON PLANTING PLANS AND DETAILS.
- ALL PLANTS AND LAWNS EXCEPT AT BUILDING 1 AND BUILDING 5 (SEE NOTE 25) SHALL BE IRRIGATED WITH AN AUTOMATIC IRRIGATION SYSTEM. REFER TO CIVIL DRAWINGS FOR POINT OF CONNECTION AND IRRIGATION SPECIFICATIONS FOR REQUIREMENTS. REFER TO PLANTING SPECIFICATIONS FOR MANUAL WATERING REQUIREMENTS FOR PLANTING AN LAWNS UNTIL ACCEPTANCE (FOR BUILDING 1).
- REFER TO CIVIL DRAWINGS FOR TREE PROTECTION FENCING PLAN, SHEET L-7 FOR TREE PROTECTION DETAIL AND THE SPECIFICATIONS SECTION 31000 SITE CLEARING. FENCING SHALL BE INSTALLED AT TREE DRIPLINE OR EDGE OF ADJACENT PAVING AND ACCORDING TO TREE REMOVAL AND PROTECTION PLANS AND WITH REVIEW OF THE LANDSCAPE ARCHITECT. REMOVAL SHALL BE AT COMPLETION OF CONSTRUCTION PER APPROVAL OF THE TREE WARDEN, LANDSCAPE ARCHITECT AND ENGINEER.
- TREE PIT LOCATIONS SHALL BE TESTED FOR DRAINAGE FOLLOWING METHODS AS REQUIRED BY SPECIFICATIONS, SECTION 313000 PLANTING AND LAWNS-TEST PITS.
- PROTECT EXISTING TREES AND PLANTS TO REMAIN WITH PROTECTION FENCING AND EROSION CONTROL MEASURES. PROTECT EXISTING SLOPE FROM EROSION AND EROSION FROM LOT INTO MILL POND FOR THE DURATION OF CONSTRUCTION ACTIVITIES. REPAIR DAMAGE TO SLOPE WITHIN TWO WORKING DAYS. MAINTAIN EXISTING CATCH BASINS, DRAIN LINES AND OUTFALLS DURING CONSTRUCTION AND KEEPING ANY SEDIMENT FROM ENTERING POND. REFER TO SECTION 3125 EROSION CONTROL.
- ALL TREES TO REMAIN ALONG THE MILL POND BANK SHALL BE CLASS 1 PRUNED (DEADWOOD AND CROSSED BRANCHES) AND BASAL SUCKERS REMOVED. DEAD TREES SHALL BE CUT AT GROUND LEVEL AND REMOVED. ROOT BALL SHALL NOT BE REMOVED UNLESS ROOTS ARE DAMAGING CRUSHED STONE PATHWAY.
- TREES THAT HAVE EXTENSIVE BEAVER DAMAGE ON TRUNKS (2 FOUND) THAT IMPAIR THE STRUCTURAL STABILITY OF THE TREE THAT COULD ENDANGER THE PUBLIC (FALL TOWARD A PATH OR PLANTED AREA) SHALL BE CUT JUST ABOVE BEAVER DAMAGE.
- STACKED SAWN TREE BRANCHES AND TRUNKS SHALL BE FLUSH CUT AND CUT WOOD REMOVED.
- INVASIVE SPECIES SUCH AS CELASTRIS SCANDENS, AILANTHUS ALTISSIMA, AND POLYGONUM SHALL BE LEGALLY REMOVED OFF SITE BY HAND INCLUDING ROOTS. POISON IVY THAT HAS GROWN UP TREES SHALL BE CUT AND CAREFULLY REMOVED OFF SITE. REFER TO SPECIFICATION SECTION 01400 SITE DEMOLITION AND REMOVALS.
- NO VEGETATION SHALL BE BURNED OR BURIED ON SITE.
- THE TREE SNAG THAT HAS FALLEN IN MILL POND BY DUCK/GOOSE AREA SHALL NOT BE REMOVED SINCE IT COULD BE A TURTLE SUNSPOT.
- REFER TO THE ORDER OF CONDITIONS FOR ADDITIONAL REQUIREMENTS
- REMOVE EXISTING ORNAMENTAL PLANTS MULCH AND ADD NEW LOAM, PLANTINGS AND MEADOW MIX. PROTECT EXISTING TREES TO REMAIN.
- SEE DETAIL 1 ON THIS SHEET (L-9) FOR PLANTING PLAN, LAYOUT, AND PLANT LIST FOR PLANTERS. PROVIDE DRIP IRRIGATION TO PLANTERS - REFER TO SPECIFICATIONS.
- AT BUILDING 5, AUTOMATIC IRRIGATION SHALL BE SUPPLIED ONLY TO THE THREE CALLED OUT LIMITED AREAS.
- MOUNT HOOB DAFFODILS (NARCISSUS MOUNT HOOB) TO BE PLANTED IN GRASS/MEADOW BEDS IN CLUSTERS OF 10 MINIMUM. LOCATION TO BE DETERMINED IN FIELD WITH LANDSCAPE ARCHITECT DURING CONSTRUCTION.

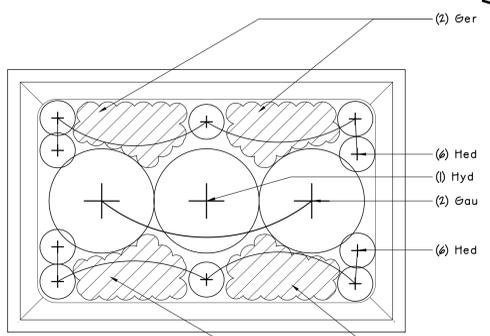

PLANTER PLANTING PLAN SCHEME A

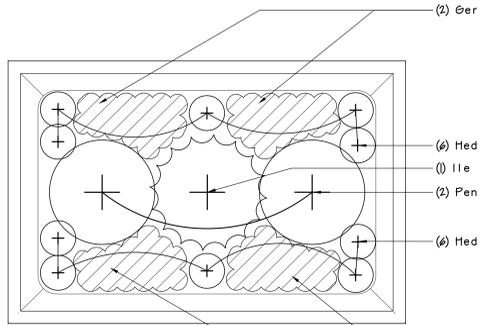

PLANTER PLANTING PLAN SCHEME B





**PLANTING SCHEME LAYOUT PLAN VIEW**

**PLANT LIST**

| SYMBOL            | QT | SCIENTIFIC NAME                          | COMMON NAME                              | ROOT  | SIZE   |
|-------------------|----|--|--|-------|--------|
| <b>SHRUBS</b>     |    |  |  |       |        |
| Ile               | 3  | Ilex crenata 'Soft Touch'                | Soft Touch Japanese Holly                | Cont. | 2 Gal. |
| Hyd               | 4  | Hydrangea macrophylla 'Ballmer'          | Original (Blue) Endless Summer Hydrangea | Cont. | 2 Gal. |
| <b>PERENNIALS</b> |    |  |  |       |        |
| Guu               | 8  | Gaura lindheimeri 'Whirling Butterflies' | Whirling Butterflies Gaura               | Cont. | 1 Gal. |
| Ger               | 28 | Geranium sanguineum var. striatum        | Bloody Cranesbill                        | Cont. | 1 Gal. |
| Pen               | 6  | Pennisetum alopecuroides 'Little Bunny'  | Little Bunny Fountain Grass              | Cont. | 1 Gal. |
| <b>VINES</b>      |    |  |  |       |        |
| Hed               | 24 | Hedera helix 'Glacier'                   | Glacier English Ivy                      | Cont. | 4" POT |

**1 SORELLA PLANTERS PLANTING PLAN AND SCHEME LAYOUT**

SCALE: N.T.S.

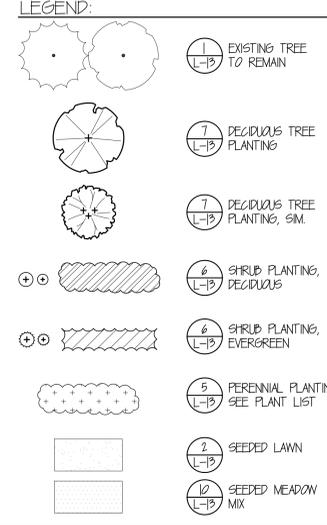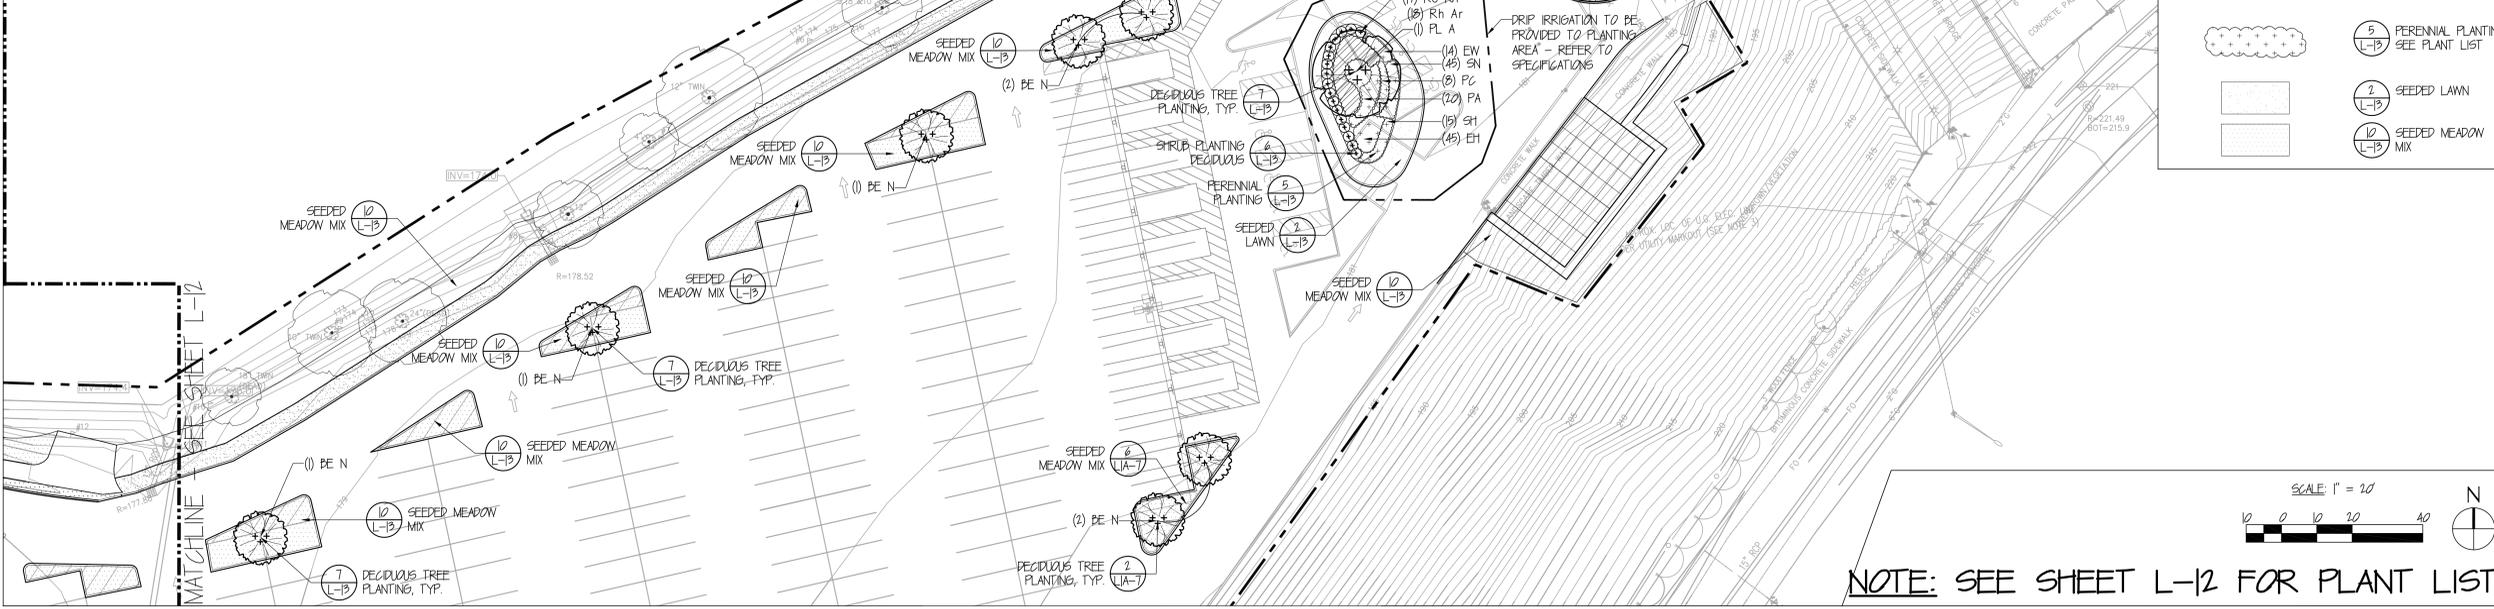

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**REVISIONS**

| NUMBER | DESCRIPTION | DATE |
|--------|-------------|------|
|        |             |      |

**STAMP**

**KEY PLAN**

DATE: 10/19/2015  
 SCALE: 1"=20'-0"  
 DRAWN BY: SM  
 PROJECT NUMBER: SARI15A.00  
 DRAWING TITLE: SITE PLANTING PLAN

**L-11**

DRAWING NUMBER

NOTE: SEE SHEET L-12 FOR PLANT LIST